

## **DEVELOPMENT SUMMARY:-**

**BUILDING ENVELOPE - 756m<sup>2</sup>** SITE COVERAGE -

> PROPOSED MECH. SHED BUILDING ENVELOPE - 1634.34m<sup>2</sup> SITE COVERAGE -20.31%

SITE AREA :-

Lot 100 Lot 101

4023.8m<sup>2</sup> 4023.8m<sup>2</sup>

TOTAL SITE AREA 8047.6m<sup>2</sup>

#### **NOTES:-**

- 1. ALL CARPARKS, PWD CARPARK SPACE & SHARED SPACE TO BE IN ACCORDANCE WITH **AS/NZS 2890.1-2004 & N.C.C. REQUIREMENTS**
- 2. ALL ACCESS PATHS FROM PWD CARPARK & SHARED SPACE TO BUILDING ENTRANCE TO BE IN ACCORDANCE WITH AS 1428 & N.C.C. REQUIREMENTS
- CIVIL DESIGN INCLUDING FINISHED FLOOR LEVELS, FINISHED PAVEMENT LEVELS, ROOFWATER & STORMWATER DRAINAGE ETC. DESIGNED BY OTHERS

NOTE :-ALL SET-OUT DIMENSIONS, FLOOR LEVELS, SETDOWNS / FALLS ETC. MUST BE VERIFIED ON SITE PRIOR TO COMMENCEMENT OF CONSTRUCTION.

#### SAFETY IN DESIGN AND CONSTRUCTION

- Notice to all persons who commissioned the design work depicted in these documents and to all those involved in the construction of the works, it's operation and it's demolition.
- 2. The construction of these works involves activities which involve some risk to the health and safety of those involved directly in the construction and any person entering the work site.
- All construction work must comply with the requirements of the Local Authority Workplace Health and Safety legislation.
- 4. It is essential that prior to the commencement of the construction, an adequate safety plan is prepared by the Principal Contractor for the proposed work in accordance with statutory requirements. The safety plan shall include appropriate work method statements for all activities. A risk analysis is to be carried out by the Contractor of all work practices and where possible all risks eliminated. Where this is not possible, the safety plan must address these risk issues with appropriate documentation for strict adherence to during construction.
- The operation of these works involves activities that have some risk to the health and safety of those using the facility. The facility requires maintenance to maintain its initial level of safety at commencement of use. Note that maintenance activities also carry health and safety risks.
- 6. The eventual demolition of these works will involve activities which have some risk to health and safety.

Please contact Osborn Consulting Engineers for information and assistance with minimising these risks.

HIRST MECHANICAL SERVICES SITE PLAN

PROPOSED STORAGE SHED Lot 100 SP255292 SPOONBILL STREET LONGREACH, QLD.

Sheet 1 of 1	WK17-0195	- AU1
	job no.:	dwg no.:
certified: POSom		rev: " <b>B</b> "
drawn: <i>K.D.</i> (April '17)	designed/checked:	P.O.

precedence over the electronic version and any discrepancies must be verified with Osborn Consulting Engineers Pty. Ltd. . Do not rely on electronic drawing files for accurate set-out. All set-out information must be verified on site prior to commencement of fabrication and construction. The builder shall obtain and use the latest revision of all drawings associated with this drawing by this office and any relevant drawings / documents prepared by other consultants.

LONGREACH REGIONAL COUNCIL

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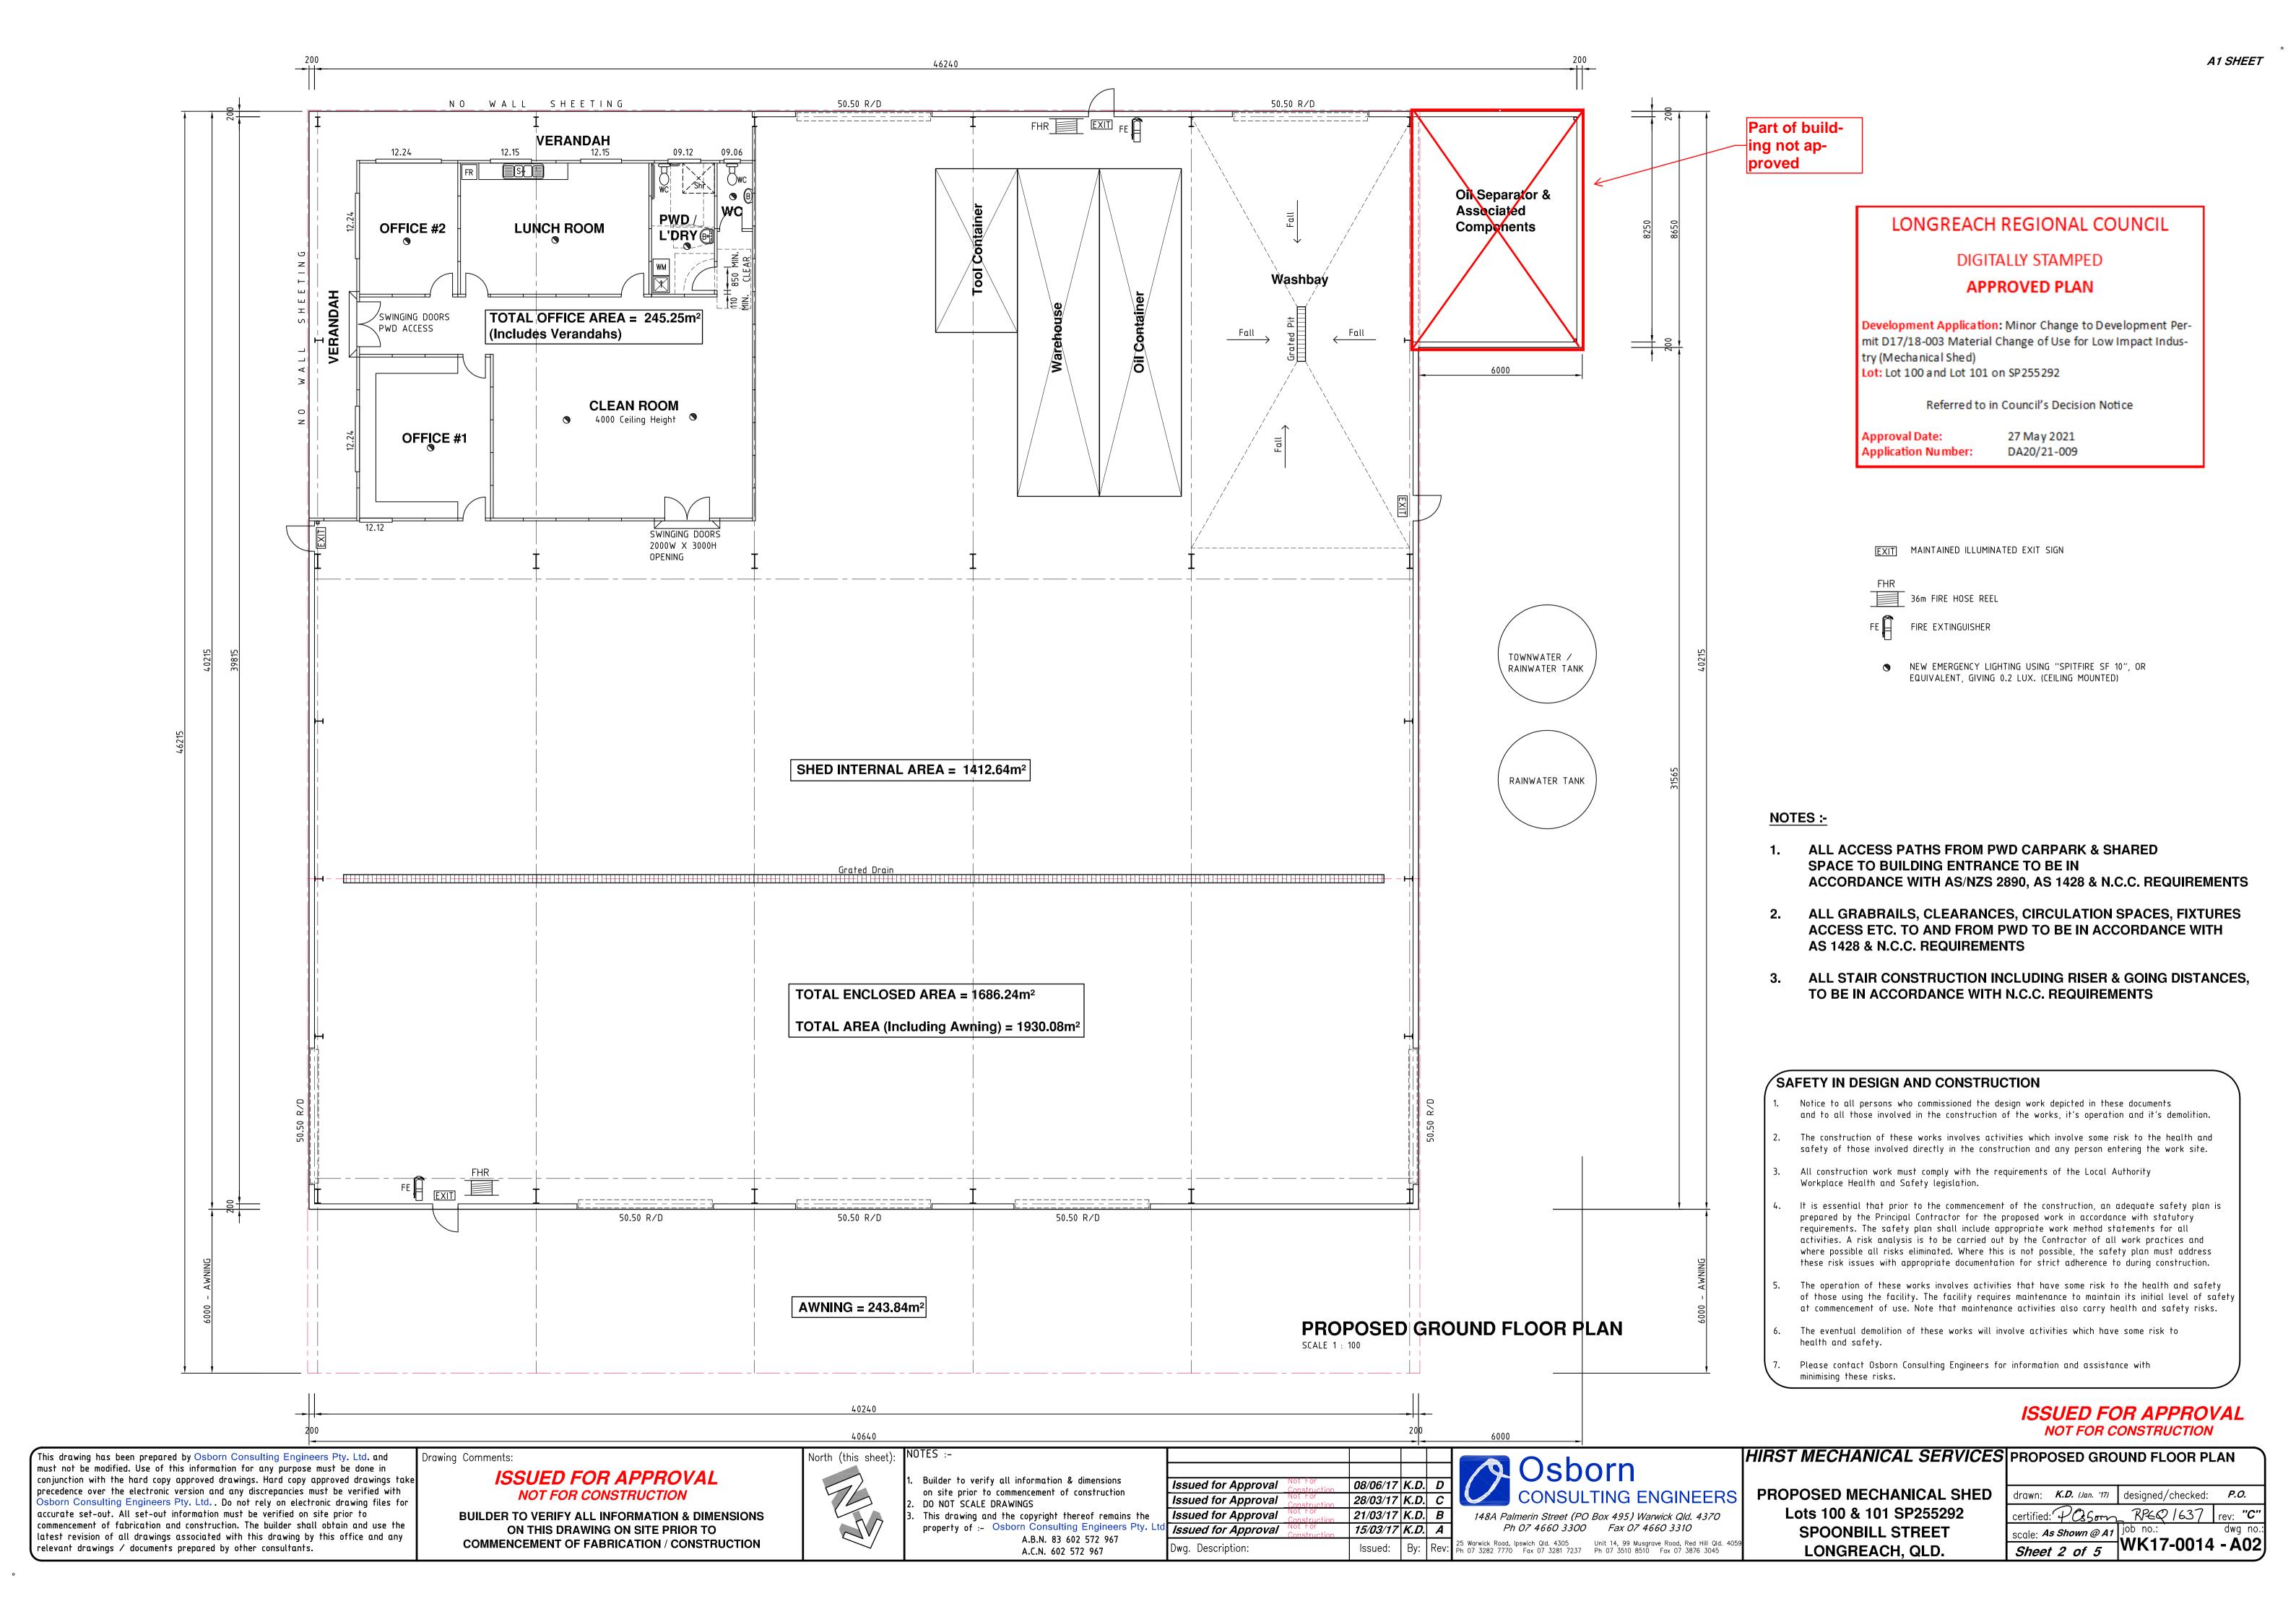
BUILDER TO VERIFY ALL INFORMATION, LEVELS & DIMENSIONS ON THIS DRAWING ON SITE & WITH DRAWINGS BY XXL SHEDS - Job No. XXL-1671 PRIOR TO COMMENCEMENT OF FABRICATION / CONSTRUCTION


on site prior to commencement of construction DO NOT SCALE DRAWINGS

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Redrawn - Issued for Appoval 16/04/21 K.D. B Issued for Appoval 17/05/17 K.D. A Owg. Description: Issued:

148A Palmerin Street (PO Box 495) Warwick Qld. 4370 Ph 07 4660 3300 25 Warwick Road, Ipswich Qld. 4305 Ph 07 3282 7770 Unit 14, 99 Musgrave Road, Red Hill Qld. 4059 Ph 07 3510 8510



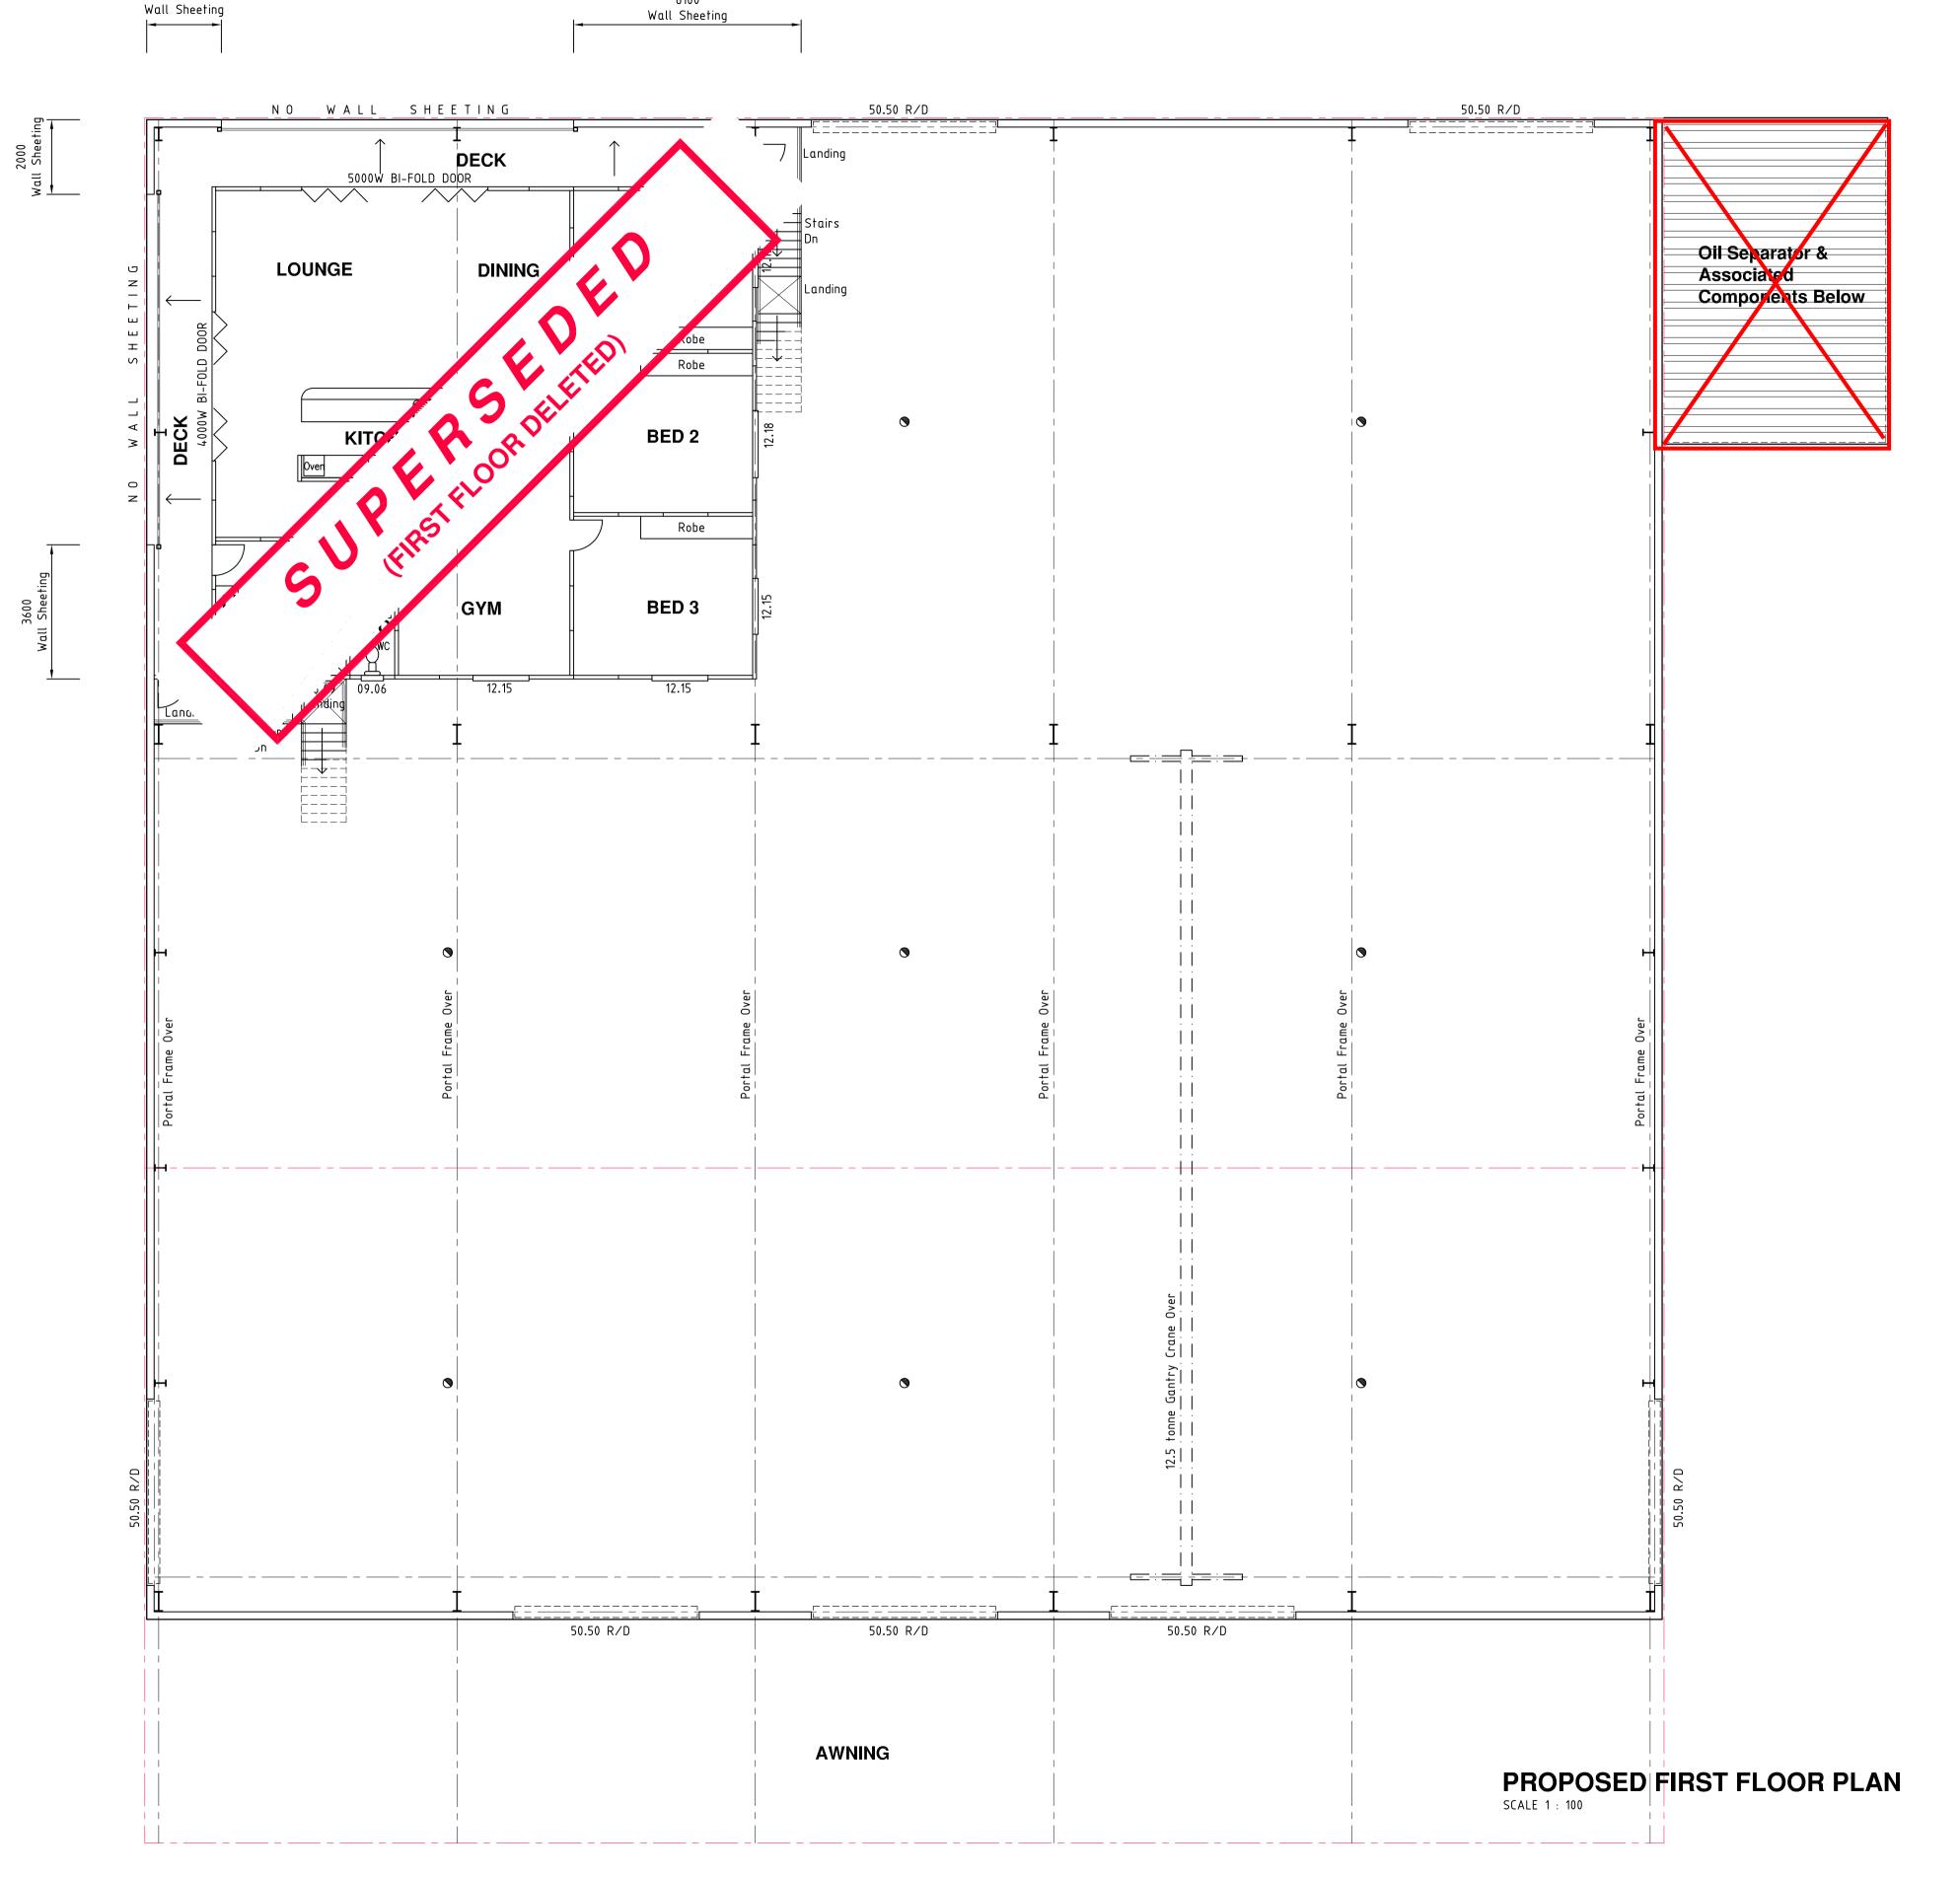

# DIGITALLY STAMPED

### **APPROVED PLAN**

Development Application: Minor Change to Development Permit D17/18-003 Material Change of Use for Low Impact Industry (Mechanical Shed)

Lot: Lot 100 and Lot 101 on SP255292

Referred to in Council's Decision Notice

Approval Date: 27 May 2021 Application Number: DA20/21-009

# **NOTES:-**

- 1. ALL ACCESS PATHS FROM PWD CARPARK & SHARED SPACE TO BUILDING ENTRANCE TO BE IN ACCORDANCE WITH AS/NZS 2890, AS 1428 & N.C.C. REQUIREMENTS
- ALL GRABRAILS, CLEARANCES, CIRCULATION SPACES, FIXTURES ACCESS ETC. TO AND FROM PWD TO BE IN ACCORDANCE WITH AS 1428 & N.C.C. REQUIREMENTS
- ALL STAIR CONSTRUCTION INCLUDING RISER & GOING DISTANCES, TO BE IN ACCORDANCE WITH N.C.C. REQUIREMENTS

NEW EMERGENCY LIGHTING USING "SPITFIRE SF 10", OR EQUIVALENT, GIVING 0.2 LUX. (CEILING MOUNTED)

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Drawing Comments:

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Osborn 148A Palmerin Street (PO Box 495) Warwick Qld. 4370 Ph 07 4660 3300 Fax 07 4660 3310

5 Warwick Road, Ipswich Qld. 4305 Unit 14, 99 Musgrave Road, Red Hill Qld. 4059 n 07 3282 7770 Fax 07 3281 7237 Ph 07 3510 8510 Fax 07 3876 3045

HIRST MECHANICAL SERVICES PROPOSED FIRST FLOOR PLAN

PROPOSED MECHANICAL SHED Lots 100 & 101 SP255292 SPOONBILL STREET LONGREACH, QLD.

Sheet 3 of 5	WK17-0014 - A0		
	job no.:	dwg n	
certified: PO50m	RPEQ 1637	rev: "D	
drawn: <i>K.D. (Jan. '17)</i>	designed/checked:	P.O.	

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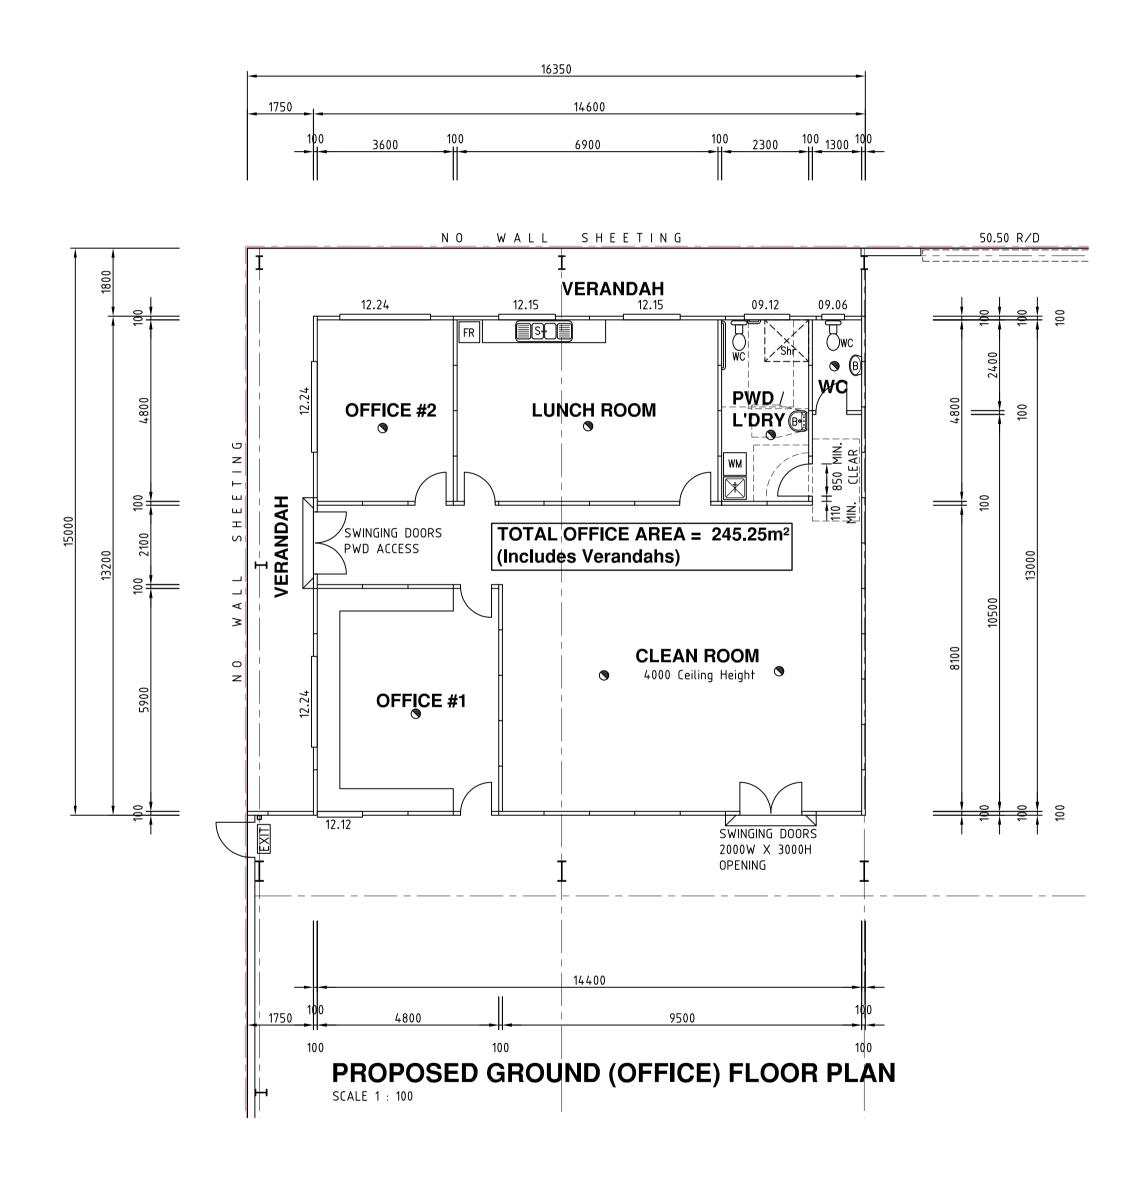
## APPROVED PLAN


Development Application: Minor Change to Development Permit D17/18-003 Material Change of Use for Low Impact Industry (Mechanical Shed)

Lot: Lot 100 and Lot 101 on SP255292

Referred to in Council's Decision Notice

Approval Date: 27 May 2021 Application Number: DA20/21-009



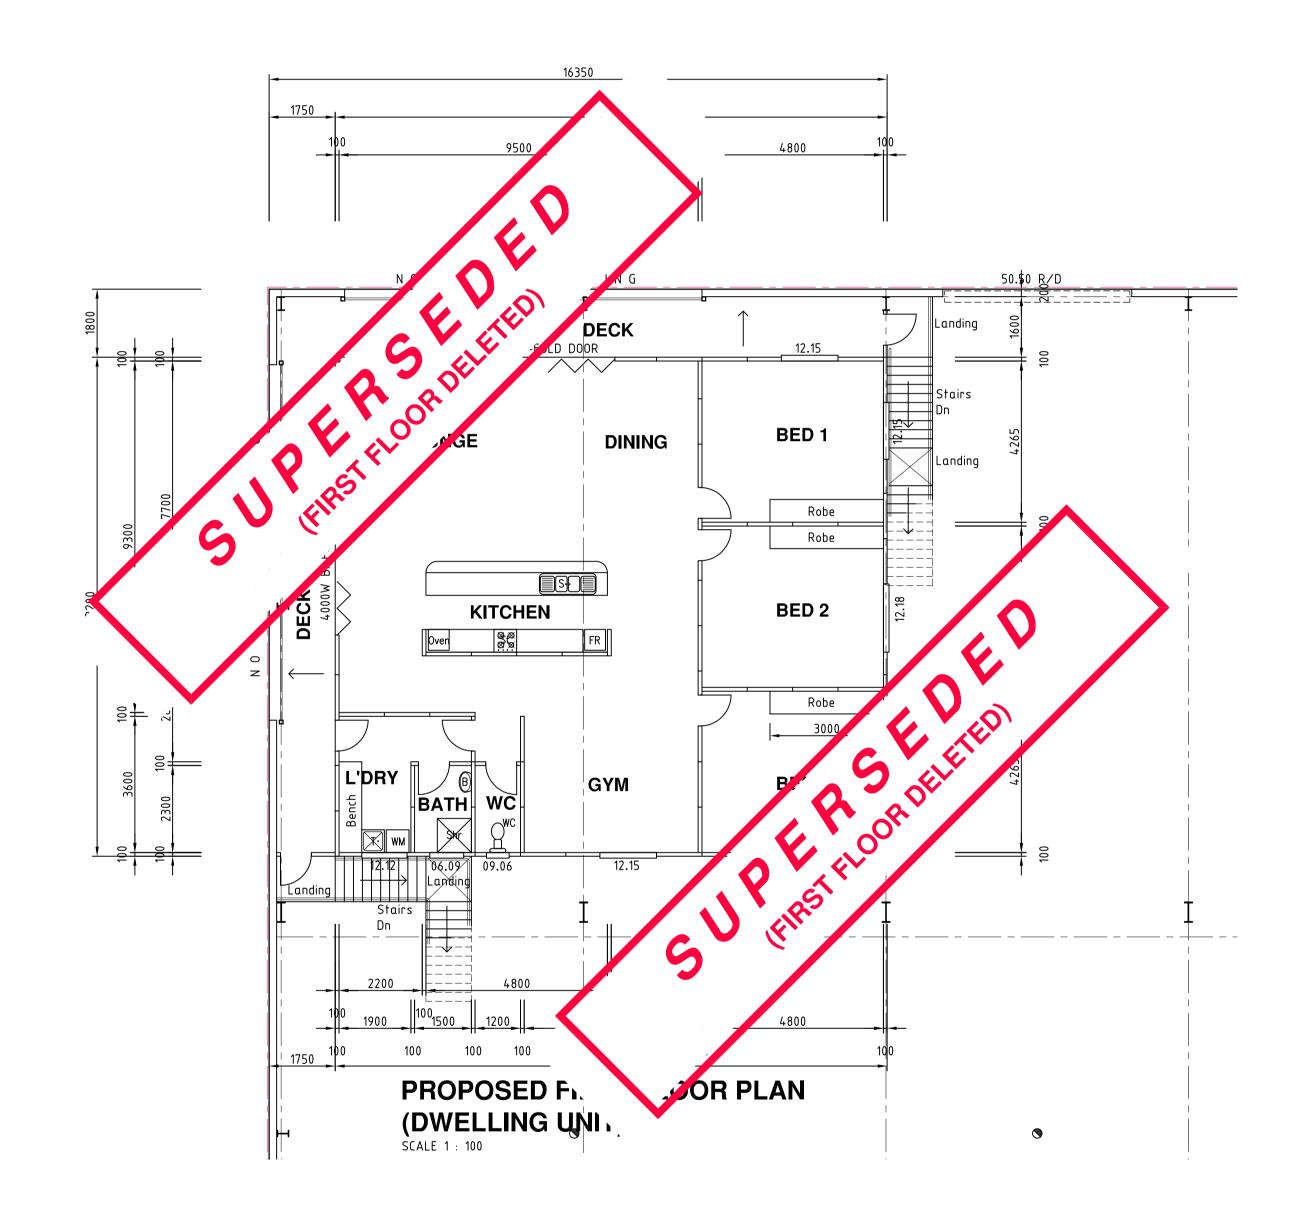

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Dwg. Description:



PROPOSED MECHANICAL SHED Lots 100 & 101 SP255292 **SPOONBILL STREET** LONGREACH, QLD.

HIRST MECHANICAL SERVICES PROPOSED GROUND (Office) & FIRST (Unit) FLOOR PLAN

> drawn: K.D. (Jan. '17) designed/checked: P.O. certified: POSSom RPEQ 1637 rev: "D" | Scale: As Shown @ A1 | job no.: dwg no.: | | WK17-0014 - A04 |

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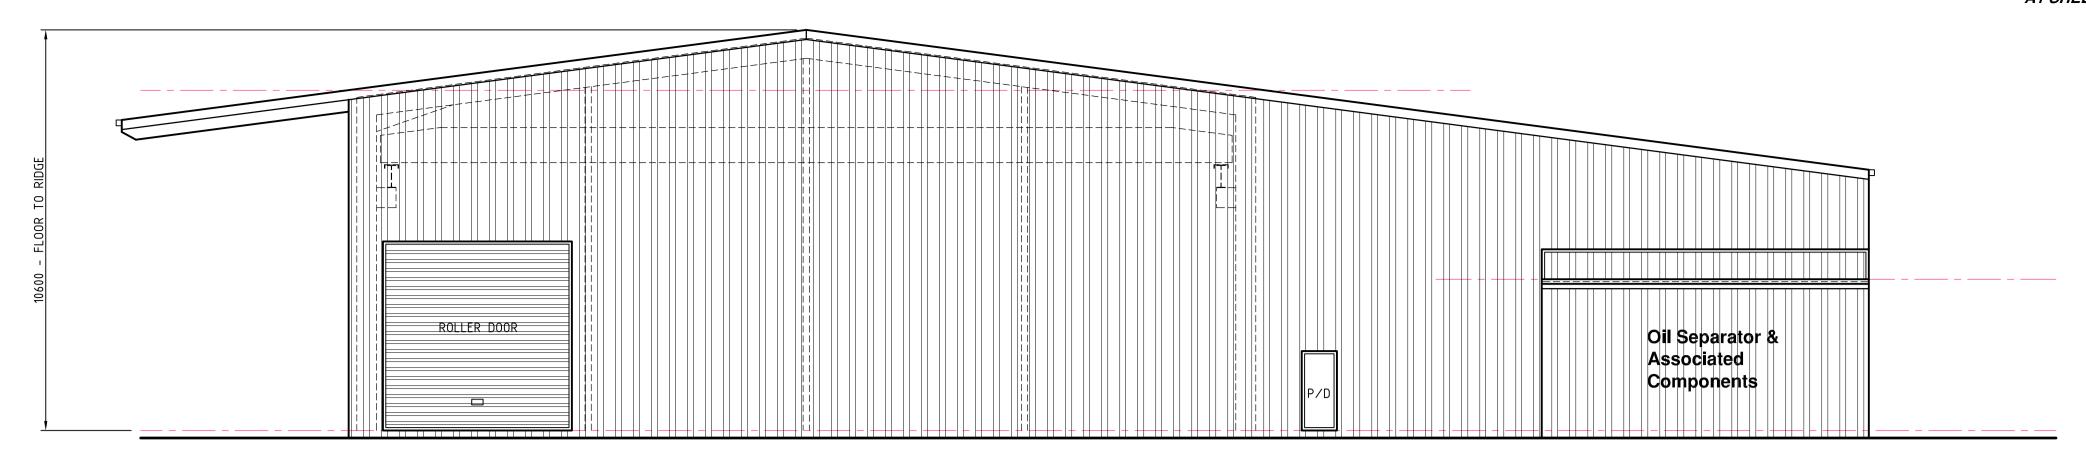
#### APPROVED PLAN


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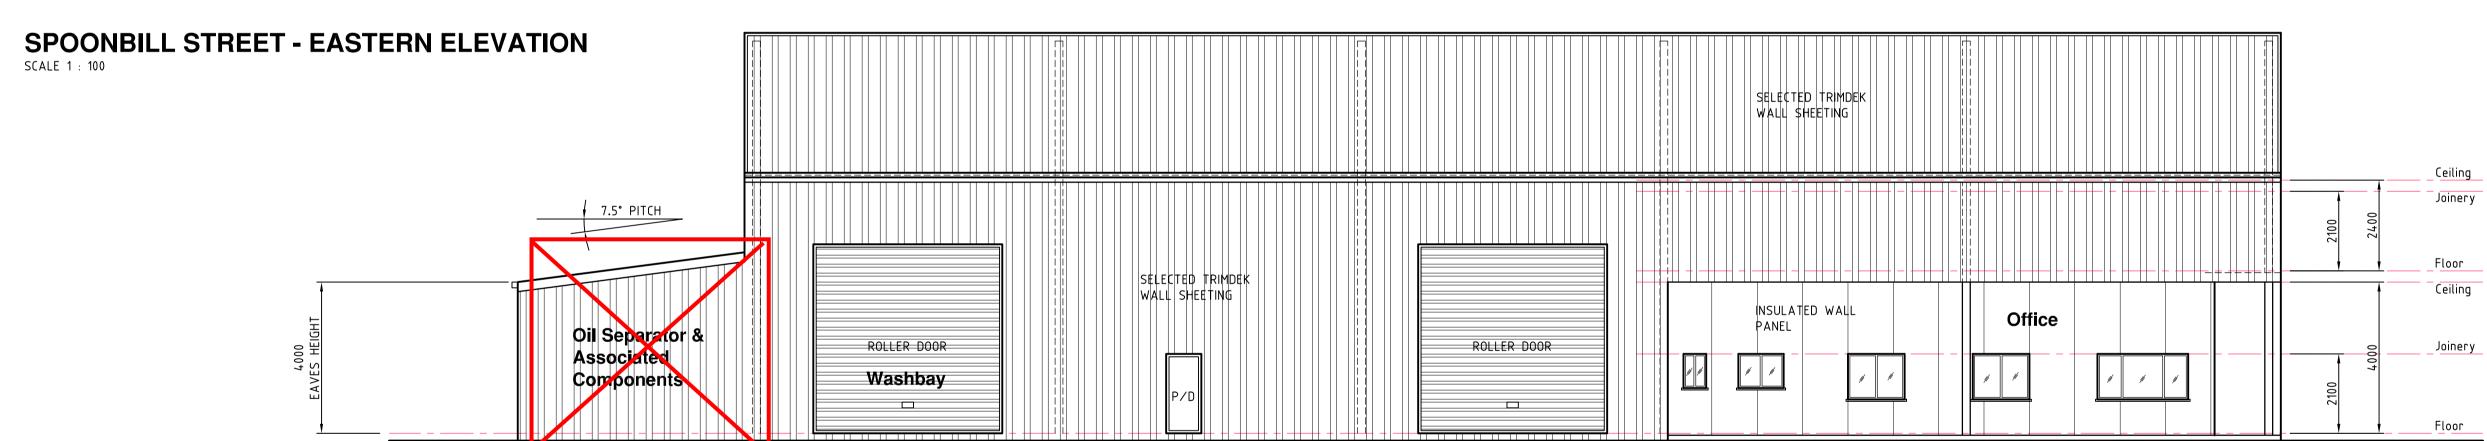
Lot: Lot 100 and Lot 101 on SP255292


Referred to in Council's Decision Notice

27 May 2021 Approval Date: Application Number: DA20/21-009





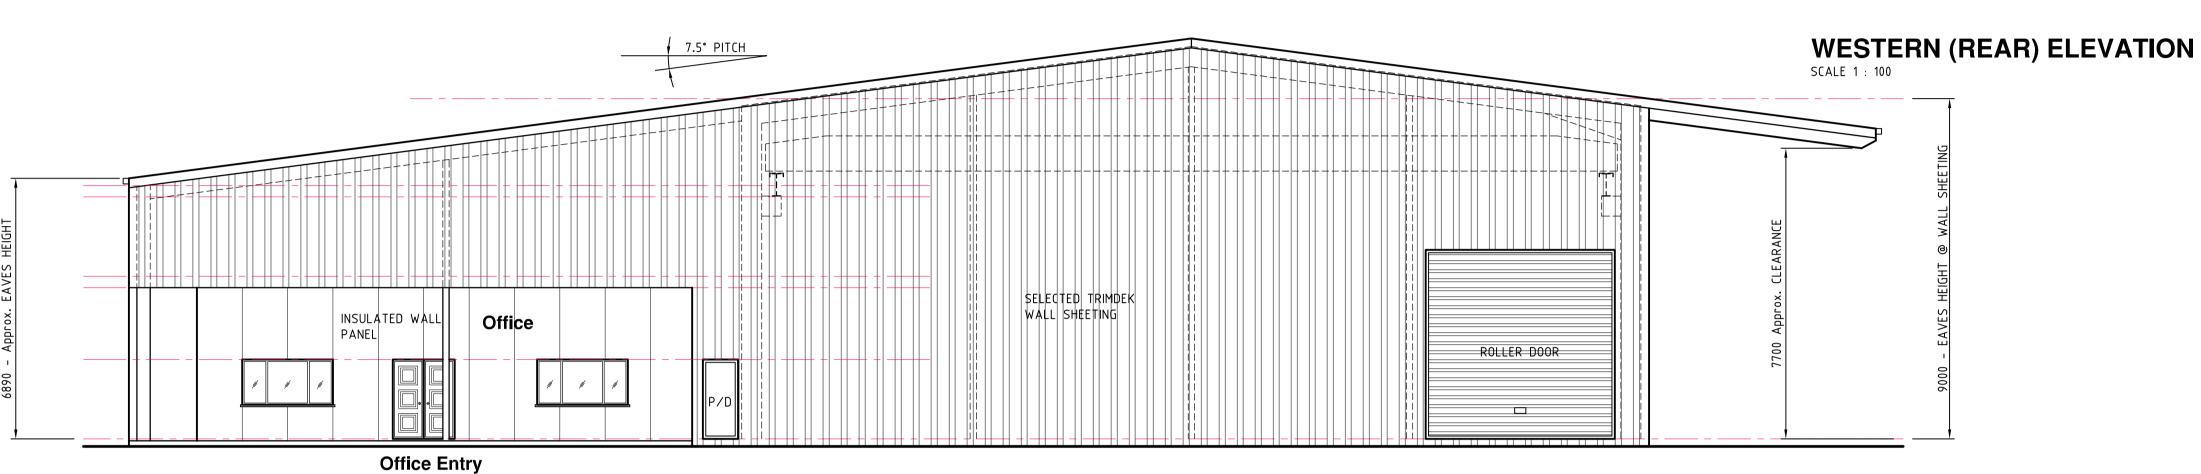

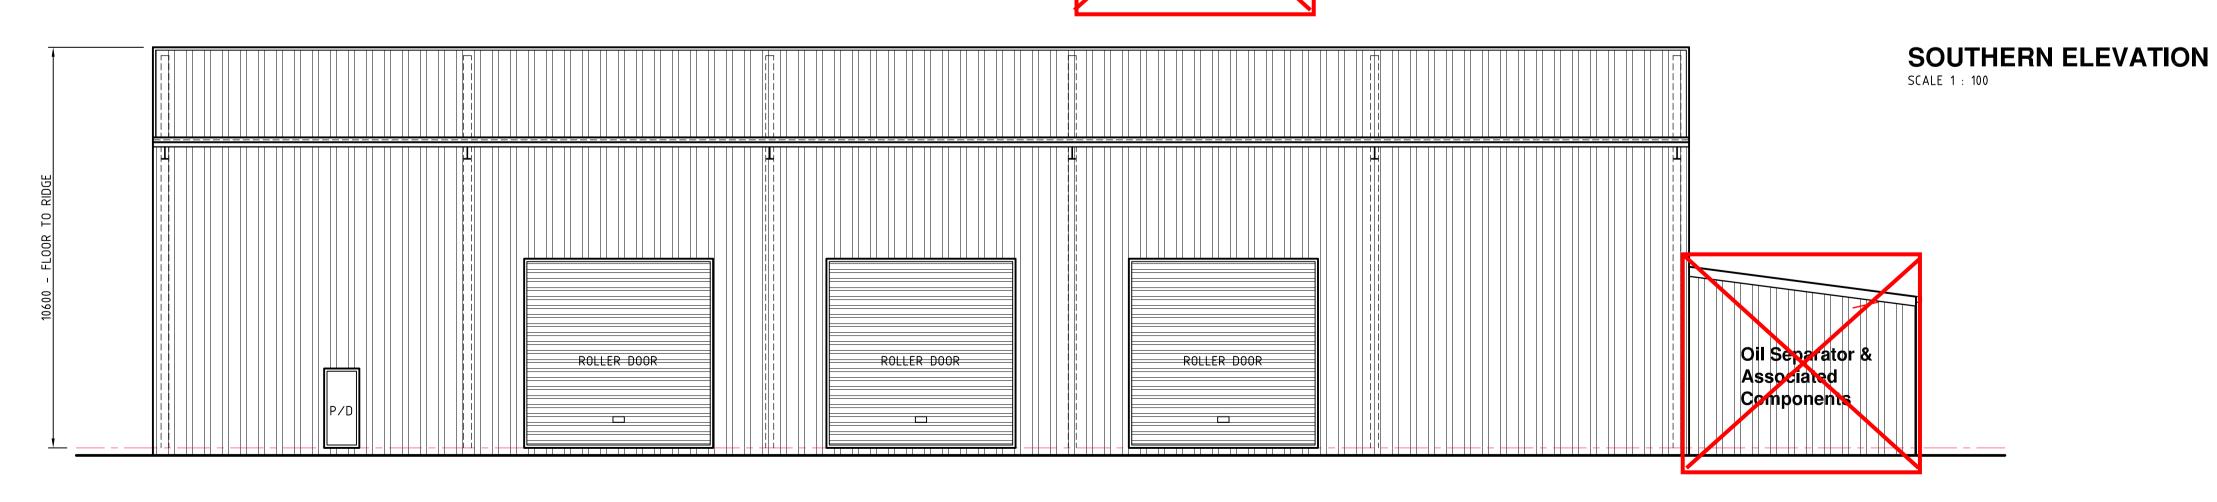

NORTHERN ELEVATION SCALE 1 : 100

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Drawing Comments:

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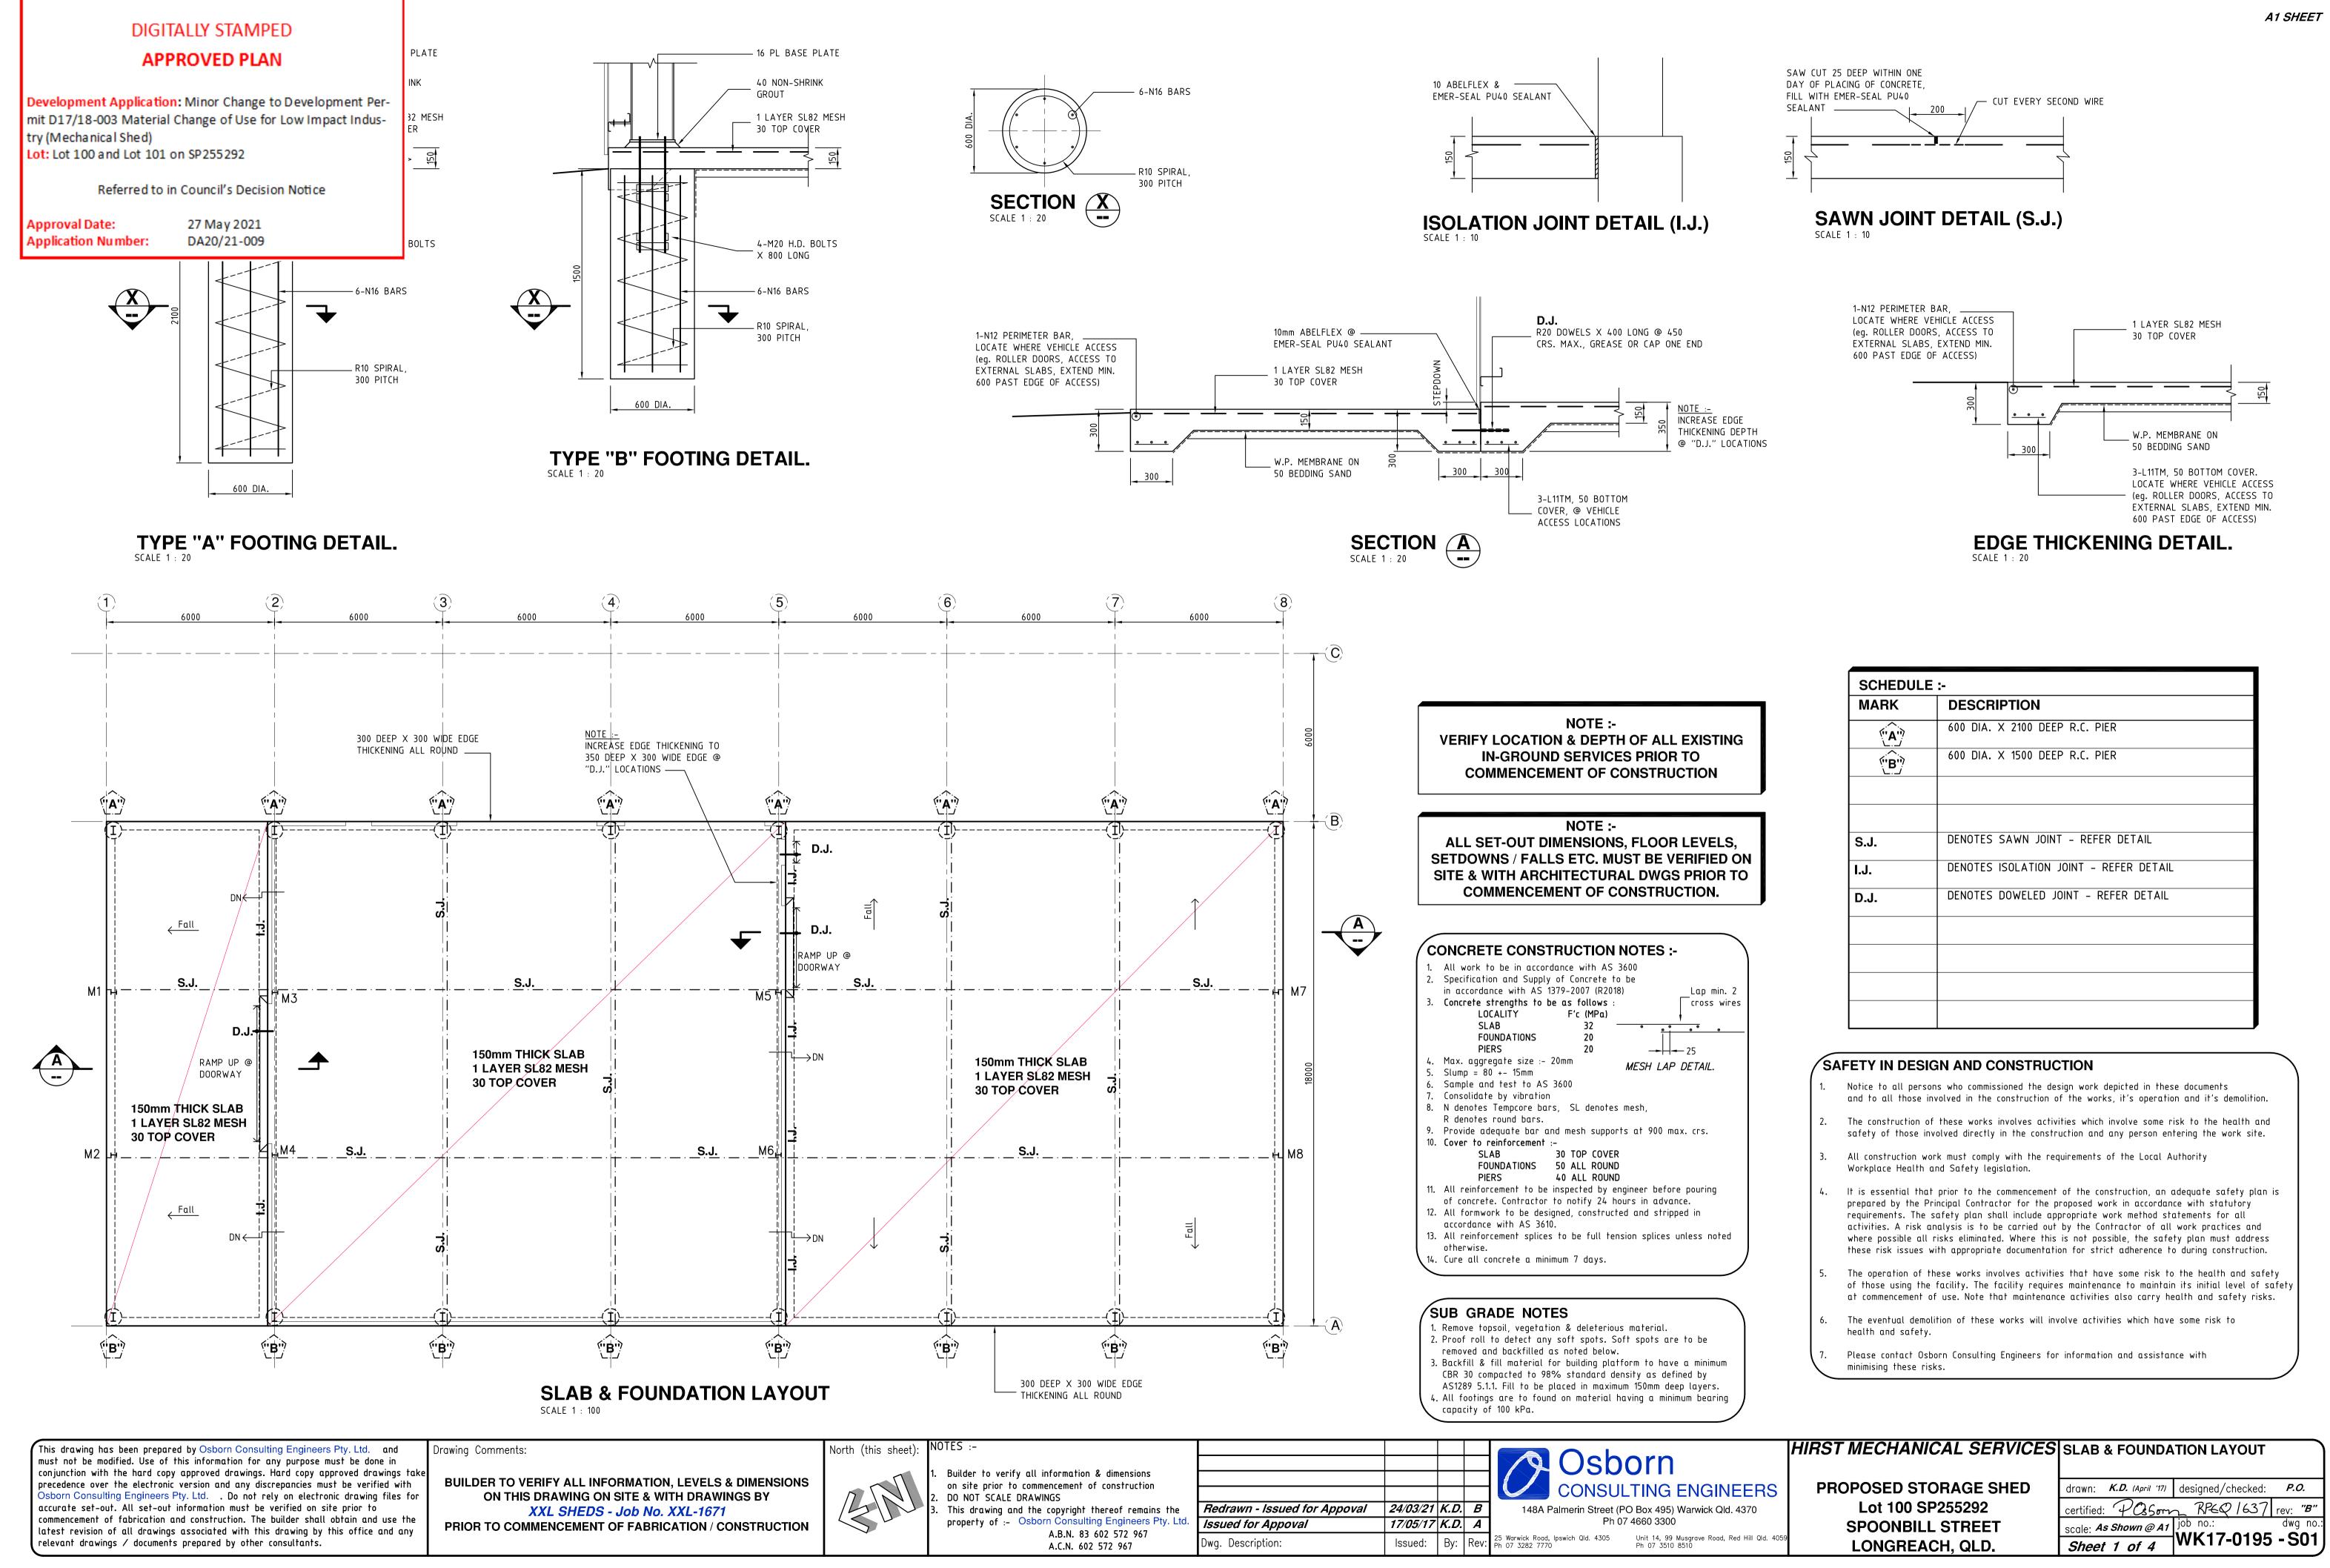
Issued for Approval Not For Construction	08/06/17	K.D.	D
Issued for Approval Not For Construction	28/03/17	K.D.	C
Issued for Approval Not For Construction	21/03/17	K.D.	В
Issued for Approval Not For Construction	15/03/17	K.D.	A
Dwg. Description:	Issued:	Ву:	Rev:


#### HIRST MECHANICAL SERVICES PROPOSED ELEVATIONS Osborn **CONSULTING ENGINEERS** 148A Palmerin Street (PO Box 495) Warwick Qld. 4370 Ph 07 4660 3300 Fax 07 4660 3310


25 Warwick Road, Ipswich Qld. 4305 Unit 14, 99 Musgrave Road, Red Hill Qld. 4059 Ph 07 3282 7770 Fax 07 3281 7237 Ph 07 3510 8510 Fax 07 3876 3045

PROPOSED MECHANICAL SHED Lots 100 & 101 SP255292 SPOONBILL STREET

drawn: *K.D. (Jan. '17)* designed/checked: *P.O.* certified: POSom RPEQ 1637 rev: "D" | Scale: As Shown @ A1 | job no.: dwg no.: | | WK17-0014 - A05 | LONGREACH, QLD.



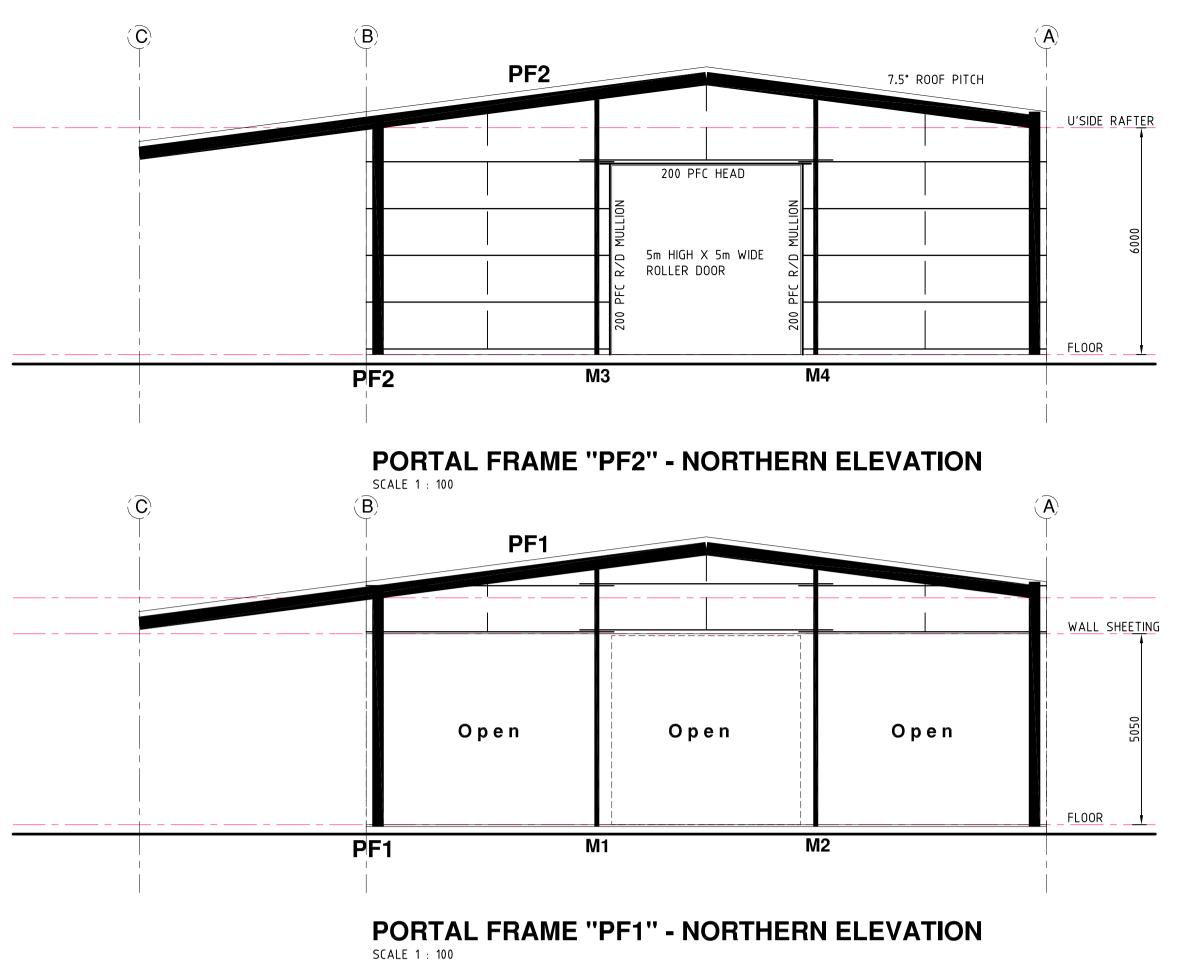


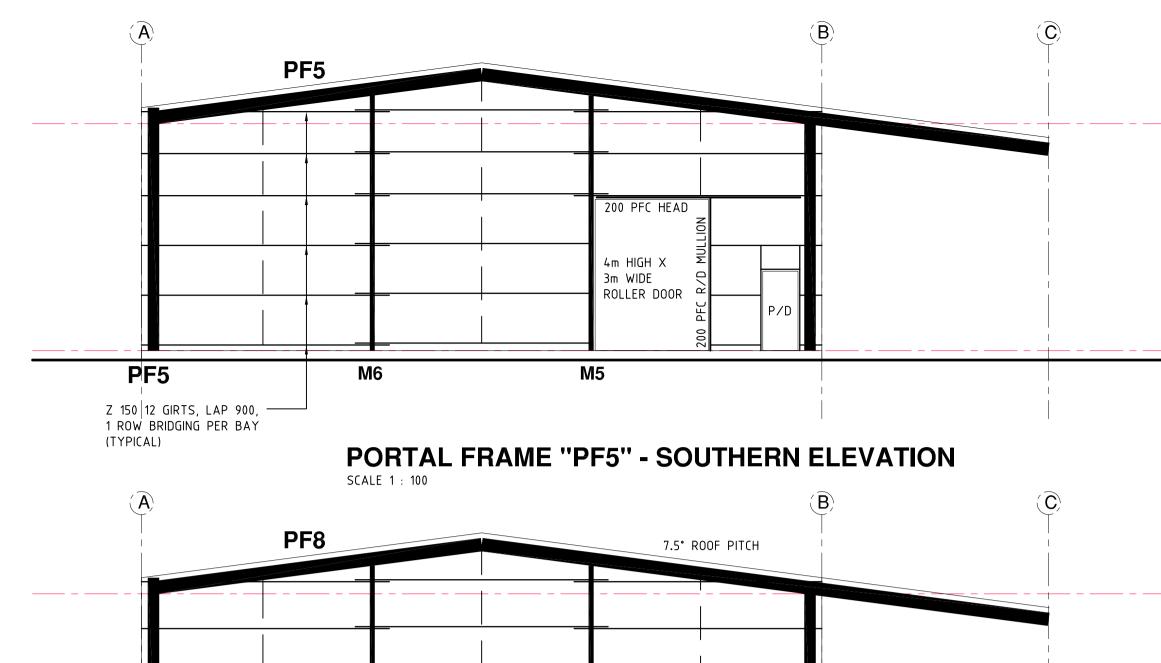


# WALL SHEETING Open Open Open PF8 М7

# PORTAL FRAME "PF8" - SOUTHERN ELEVATION



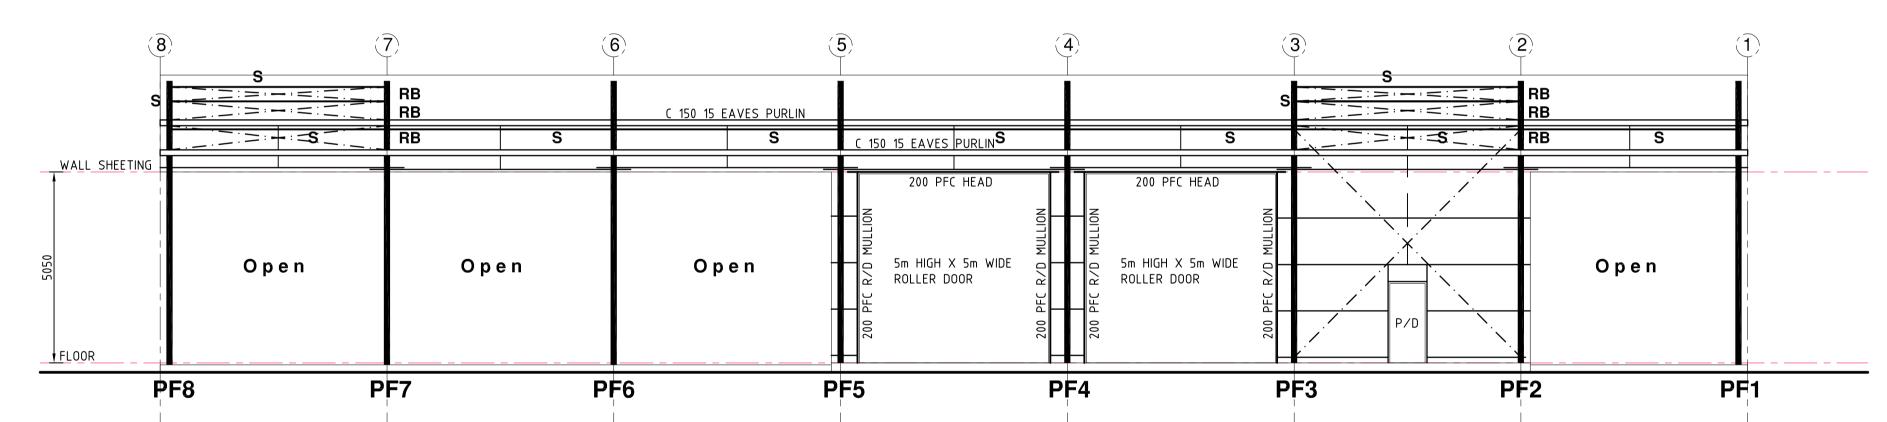

**EASTERN ELEVATION** 

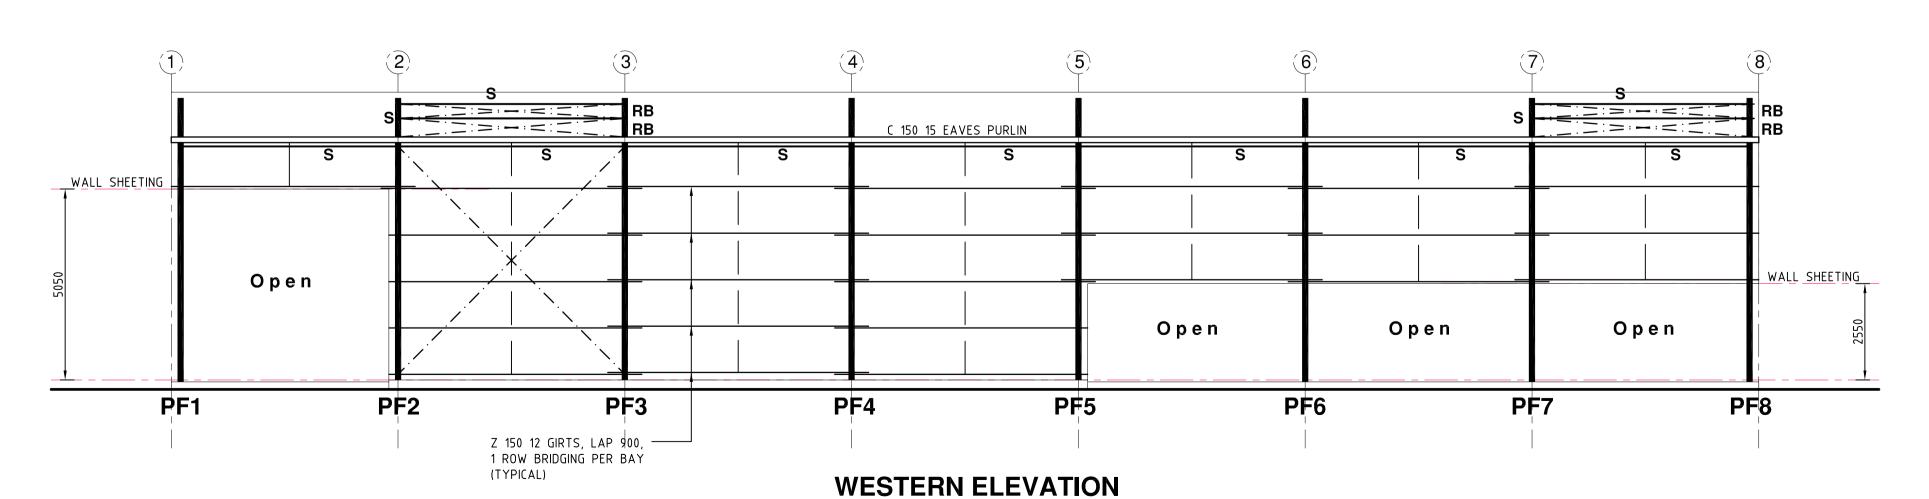

NOTE :-ALL SET-OUT DIMENSIONS, FLOOR LEVELS, SETDOWNS / FALLS ETC. MUST BE VERIFIED ON SITE & WITH ARCHITECTURAL DWGS PRIOR TO COMMENCEMENT OF CONSTRUCTION.

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SCALE 1 : 100

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Unit 14, 99 Musgrave Road, Red Hill Qld. 4059 Ph 07 3510 8510

25 Warwick Road, Ipswich Qld. 4305 Ph 07 3282 7770

PROPOSED STORAGE SHED Lot 100 SP255292 **SPOONBILL STREET** 

drawn: K.D. (April '17) designed/checked: P.O. certified: POSom RPEQ 1637 rev: "B" scale: As Shown @ A1 job no.: Sheet 3 of 4 WK17-0195 - S03 LONGREACH, QLD.

HIRST MECHANICAL SERVICES STRUCTURAL ELEVATIONS

#### **CODE OF PRACTICE**

#### for general environmental duty

#### HIRST MECHANICAL, Spoonbill Street, Longreach

This Code of Practice has been prepared using the key principals of the "Code of Practice for Motor Vehicle Workshop Operations", designed to comply with the Environmental Protection Act 1994

Performance outcome 1: There is no discharge to land or water of contaminants that may harm the environment or create a nuisance from the operation of the activity.

- Chemicals and other liquids (fuels, solvents, oils, batteries and coolants) are kept in an impervious containment system, and managed to prevent the release of contaminants to waters or land. The containment may take the form of fixed bunding, self bunding pallets or double skinned containers.
- Chemicals and other liquids are stored and used undercover.
- Bunds are sized to hold the contents of the largest container stored inside the bund, plus 10% of its volume.
- Repairs in the workshop are undertaken on a sealed surface drained to an oil/water separator or a tank for collection by a licensed waste contractor.
- Any liquids collected in the bunded areas will be treated in an oil/water separator or collected by a licensed waste contractor.
- When applicable, drip trays are used under vehicles to catch spent oil, solvents or detergents.
- All storage containers and transfer equipment will be checked regularly to detect leakage.
- Spill kits and personal protective equipment are kept in clearly identified locations. Staff are trained so they know how to use it.
- Clean stormwater is diverted away from areas that could potentially be contaminated.
- The wash bay is either connected to the sewer under a trade waste agreement or fitted with a water treatment and recycling system or stored and collected by a licensed waste transporter.
- The oil separator is serviced regularly and a log is kept of services.
- Any drains on the site that are connected to the stormwater system will be clearly marked. This will ensure everyone is aware that 'the stormwater drain is just for rain'.

Performance outcome 2: There is no discharge to air of contaminants that may harm the environment or create a nuisance from the operation of the activity.

Hirst Mechanical will not undertake powder coating or the like. The only chance of air contaminants will come from dust.

- Potential for dust from the driveways is minimised by keeping the compacted gravel surface in good condition.
- Workshop floors are cleaned regularly to keep dust levels to a minimum. Floors are not cleaned by blowing with compressed air

Performance outcome 3: Noise nuisance is prevented or minimised at noise sensitive places.

All of the adjoining land on Spoonbill Street, is in the Industry zone. Despite this, there are two residential dwellings located on the opposite side of Spoonbill Street, approximately 55m and 70m from the closest point of the workshop. Spoonbill Street is a heavy vehicle route, and these houses are already subjected to noise, light and vibration impacts. It is not possible that sounds from the workshop would exceed the noise levels, light spill and vibrations that already occur.

- The mechanical shed is setback 15m from the road frontage, which will be landscaped with screening vegetation and grasses.
- All vehicles will enter the building from the rear, minimising noise along the frontage.
- The workshop minimises noise at noise sensitive places in the evening, night and early morning.
- All workshop activities are conducted indoors, within the building, away from noise sensitive land uses.
- Noise and vibrations from mechanical equipment are reduced, where possible, by:
  - o mounting on rubber mats
  - o increasing mass weight of equipment.

Performance outcome 4: Waste production and disposal must be minimised and waste must be managed so it does not harm the environment or create a nuisance from the operation of the activity.

- All waste materials will be reused, recycled or taken to a waste disposal facility that can lawfully receive them.
- All recyclable wastes will be segregated for collection by waste recyclers, contractors or lawful disposal.
- Waste tyres are collected for recycling where available.
- Waste batteries are stored and collected by Battery Man as required.
- Parts are cleaned in a 'parts washer tub'. The used washing liquid is stored with the waste oil.
- In the event of an oil spill in the workshop, it is cleaned up with a flat shovel and added to the waste oil storage. Remnants of the spill are cleaned with rags and solvent. Used solvent is stored with the waste oil.
- Workshop floors are cleaned regularly. All residue from floor cleaning is directed to the wash bay drain, which is then directed to the oil separator.
- Metals, such as lead, copper and steel, are stored in a secure container for collection by a metal recycler.
- There will be no burning of waste.
- Regulated wastes are separated and removed by a licensed waste transporter. Regulated
  wastes include, but are not limited to: coolant, waste oil, caustic solvents, brake fluid, fuel,
  workshop sweepings, spill products, oil filters, spent abrasive material, and containers
  contaminated with chemicals.
- Waste containers are clearly labelled and located in easy access areas to encourage use.
- Records for the removal and disposal of all types of waste will be kept.
- Only dry, solid wastes will be placed in the Council collection waste bin.

#### LONGREACH REGIONAL COUNCIL

#### DIGITALLY STAMPED

#### APPROVED PLAN

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